


05/24/2023

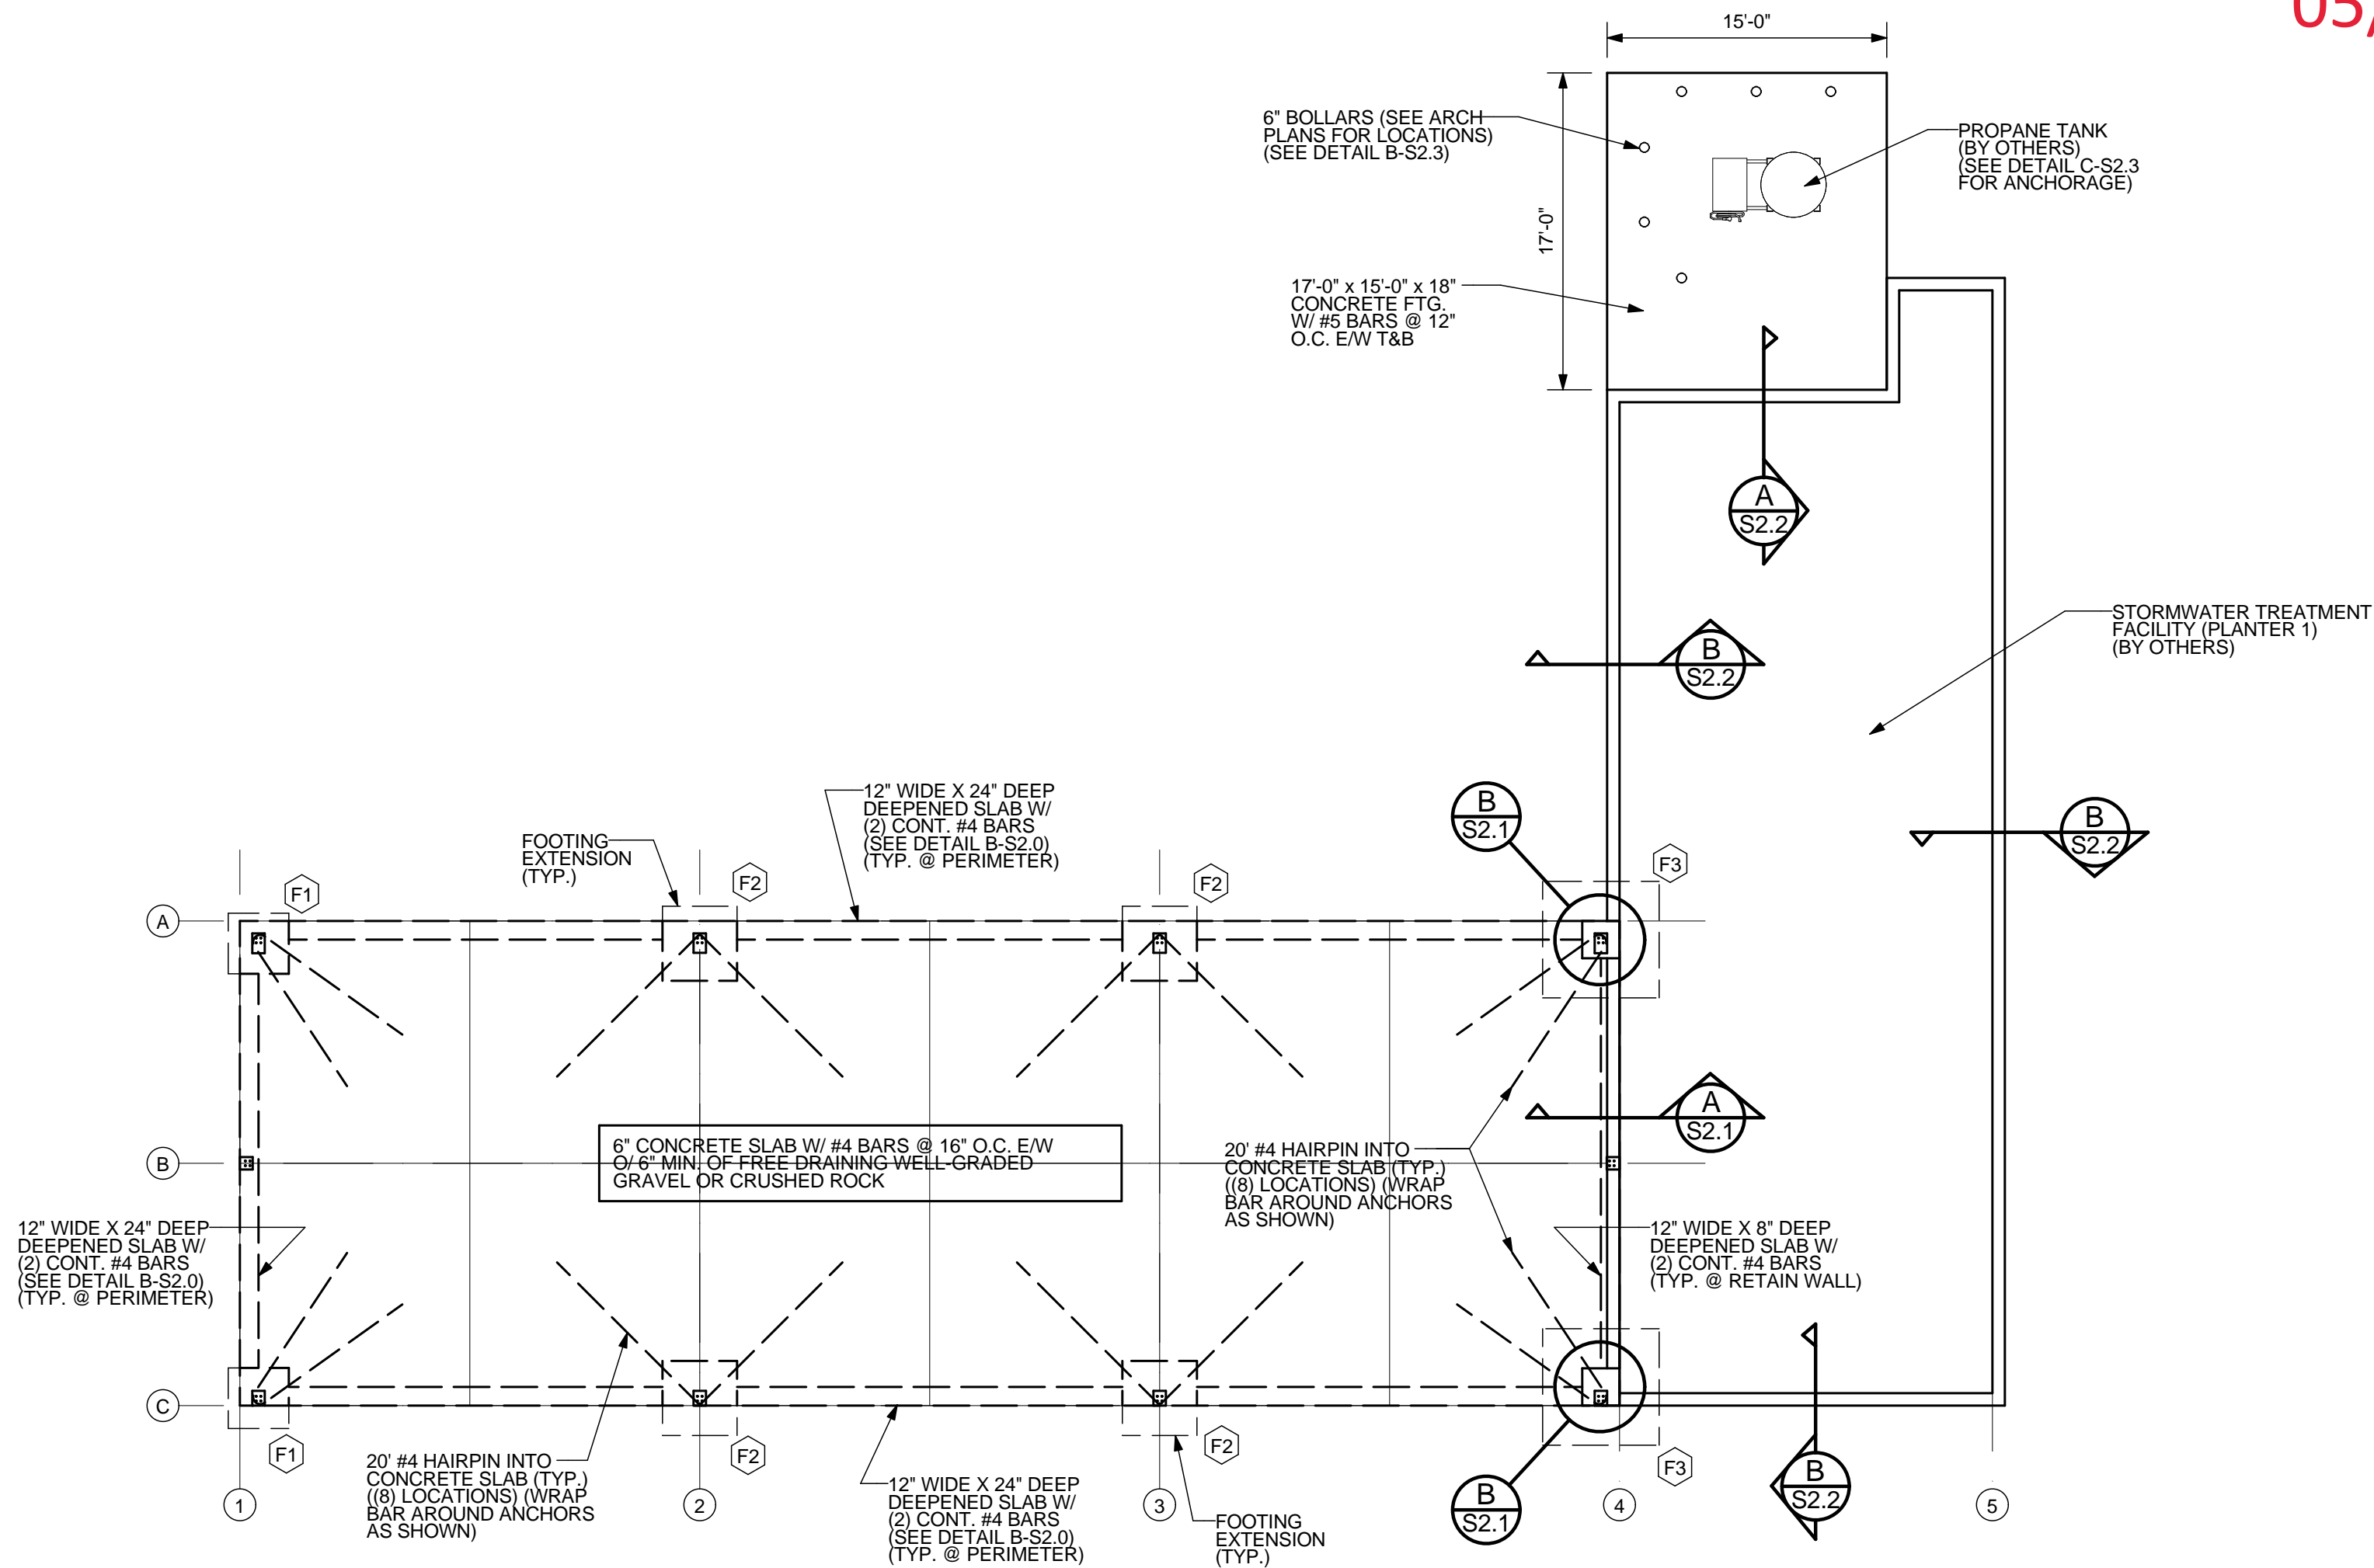

**A**  
**S1.0** FOUNDATION PLAN  
SCALE: 1/8" = 1'-0"

FOOTING SCHEDULE

FTG. MARK	SIZE (LxWxH)	REINFORCEMENT	DETAIL REFERENCE
F1	3'-3" x 3'-3" x 24"	#5 BARS @ 8" O.C. E/W	A-S2.0
F2	4'-0" x 4'-0" x 24"	#5 BARS @ 8" O.C. E/W	A-S2.0
F3	6'-3" x 6'-3" x 14"	#5 BARS @ 8" O.C. E/W T&B	B-S2.1

ANCHOR BOLTS

DIAMETER	EMBEDMENT DEPTH	TYPE
3/4"	21" (U.N.O.)	SIMPSON PAB6 OR EQUIVALENT

CONSTRUCTION NOTES

- 1) USE 3000 PSI CONCRETE AND 60000 PSI STEEL REINFORCEMENT. ALL CALCULATIONS WERE BASED ON 2500 PSI CONCRETE.
- 2) ALL CONCRETE SLAB AREAS ARE TO BE REINFORCED WITH #4 BARS @ 16" O.C. E/W UNLESS NOTED OTHERWISE.
- 3) PROVIDE CONTROL JOINTS IN SLAB AREAS AT MAXIMUM 20' O.C. E/W. SEE DETAIL C-S2.0.
- 4) BUILDER MUST FOLLOW ALL MANUFACTURER'S ENGINEERED DRAWINGS.
- 5) STABILITY ENGINEERING'S SOLE RESPONSIBILITY IS THE PROPER SUPPORT OF THE PROPOSED STRUCTURE. DESIGN OF THE STEEL STRUCTURE IS THE RESPONSIBILITY OF THE BUILDING MANUFACTURER.
- 6) CONTRACTOR IS RESPONSIBLE FOR ANCHOR BOLT PLACEMENT. PROVIDE BOLTS AS REQUIRED FOR BUILDING FRAME AND WALL COMPONENTS.



REVISIONS	No.	DATE	DESCRIPTION

PROJECT: **WILCO HAY SHED, PLANTER & TANK**  
LOCATION: **W11TH & WILLOW CREEK EUGENE, OREGON 97402**

SHEET TITLE: **FOUNDATION PLAN**  
CLIENT: **DICKERHOOF PROPERTIES**

**STABILITY ENGINEERING INC.**  
777 NE 2ND ST. SUITE 280  
P.O. BOX 2646, CORVALLIS, OR 97339  
TEL.: (541)223-5360 FAX: (541)223-5278

JOB NO. 22-0690  
DATE: 05/24/2023  
DRAWN: PS  
SCALE: AS SHOWN  
SHEET

**S1.0**